#### DA Form 2 – Building work details

Approved form (version 1.2 effective 7 February 2020) made under Section 282 of the Planning Act 2016.

This form must be used to make a development application involving building work.

For a development application involving **building work only**, use this form (*DA Form 2*) only. The DA Forms Guide provides advice about how to complete this form.

For a development application involving **building work associated and any other type of assessable development** (i.e. material change of use, operational work or reconfiguring a lot), use *DA Form 1 – Development application details* **and** parts 4 to 6 of this form (*DA Form 2*).

Unless stated otherwise, all parts of this form **must** be completed in full and all required supporting information **must** accompany the development application.

One or more additional pages may be attached as a schedule to this development application if there is insufficient space on the form to include all the necessary information.

This form and any other form relevant to the development application must be used to make a development application relating to strategic port land and Brisbane core port land under the *Transport Infrastructure Act 1994*, and airport land under the *Airport Assets (Restructuring and Disposal) Act 2008*. For the purpose of assessing a development application relating to strategic port land and Brisbane core port land, any reference to a planning scheme is taken to mean a land use plan for the strategic port land, Brisbane port land use plan for Brisbane core port land, or a land use plan for airport land.

**Note:** All terms used in this form have the meaning given under the Planning Act 2016, the Planning Regulation 2017, or the Development Assessment Rules (DA Rules).

#### PART 1 - APPLICANT DETAILS

1) Applicant details	
Applicant name(s) (individual or company full name)	Margaret Cochrane
Contact name (only applicable for companies)	
Postal address (PO Box or street address)	775 Coles Creek Road
Suburb	Pomona
State	QLD
Postcode	4568
Country	Australia
Contact number	0439 989 982
Email address (non-mandatory)	marg@margcochrane.com.au
Mobile number (non-mandatory)	
Fax number (non-mandatory)	
Applicant's reference number(s) (if applicable)	

#### PART 2 - LOCATION DETAILS

2) Location of the premises (complete 2.1 and 2.2 if applicable)
<b>Note</b> : Provide details below and attach a site plan for any or all premises part of the development application. For further information, see <u>DA Forms Guide</u> : Relevant plans.
2.1) Street address and lot on plan
Street address AND lot on plan (all lots must be listed), or
Street address <b>AND</b> lot on plan for an adjoining or adjacent property of the premises (appropriate for development in water but adjoining or adjacent to land e.g. jetty, pontoon. All lots must be listed).



Unit No.	Street No.	Street Name and Type	Suburb		
	24	Horton Street	Biggenden		
Postcode	Lot No.	Plan Type and Number (e.g. RP,	SP) Local Governi	ment Area(s)	
4621	22	SP198429	North Burnett	Regional	
2.2) Additional premises					
Additional p	remises are rele	vant to this development applicat	ion and the details of the	ese premises have been	
attached in	a schedule to thi	is development application			
Not required	1				
		nents over the premises?			
Note: Easement us how they may affect	ses vary throughout ct the proposed deve	Queensland and are to be identified corre elopment, see the <u>DA Forms Guide</u>	ectly and accurately. For furthe	r information on easements and	
		s, types and dimensions are inclu	ıded in plans submitted v	with this development	
application		, 31	•	•	
⊠ No					
PART 3 – Fl	JRTHER DI	ETAILS			
4) Is the applica	ation only for bui	lding work assessable against the	e building assessment p	rovisions?	
	ed to 8)				
☐ No					
<b>5</b> ) 1 1 1 1 1 1 1 1 1 1 1 1 1 1 1 1 1 1 1		, , , , , , , , , , , , , , , , , , , ,			
5) Identify the a	issessment man	nager(s) who will be assessing thi	s development application	on .	
6) Has the loca	I government ag	reed to apply a superseded plani	ning scheme for this dev	elonment application?	
		•		elopment application:	
	•	notice is attached to this develor en to have agreed to the superse	• •	quest – relevant documents	
attached	vormilon is tak	on to have agreed to the superse	aca planning sonome re	quest relevant decaments	
□No					
7) Information r	equest under Pa	art 3 of the DA Rules			
		ation request if determined neces	•	nt application	
	•	information request for this develo	•		
Note: By not agreeing to accept an information request I, the applicant, acknowledge:  that this development application will be assessed and decided based on the information provided when making this development					
application an	d the assessment m	anager and any referral agencies relevan	t to the development application	on are not obligated under the DA	
parties.	Rules to accept any additional information provided by the applicant for the development application unless agreed to by the relevant parties.				
<ul> <li>Part 3 of the DA Rules will still apply if the application is an application listed under section 11.3 of the DA Rules.</li> </ul>					
Further advice about information requests is contained in the <u>DA Forms Guide</u> .					
8) Are there an	v associated dev	velopment applications or current	approvals?		
	•	or include details in a schedule to	· ·	cation	
⊠ No	ac details below	or morado detallo iri a soriedale te	Tino development applic	Sallon	
List of approva	/development	Reference	Date	Assessment manager	
application					
☐ Approval					
Developme	nt application				
☐ Approval					
Developmo	at application				

9) Has the portable long service	e leave levy been	paid?		
Yes – a copy of the receipte	d QLeave form is	attached to this d	evelopment applic	ation
☐ No – I, the applicant will pro				
				ne assessment manager may rice leave levy has been paid
Not applicable (e.g. building	•		•	· · · · · · · · · · · · · · · · · · ·
	Date paid (dd/mm/		1	ımber (A, B or E)
\$	2 оло рола (а а, , , , , , ,	<del>337</del>		
10) Is this development applica notice?	tion in response to	a show cause no	otice or required a	s a result of an enforcement
Yes – show cause or enforce	ement notice is at	ached		
No Show cause of emole	cinent notice is at	acrica		
11) Identify any of the following	further legislative	requirements tha	t apply to any asp	ect of this development
application	J			·
☐ The proposed development				
government's <b>Local Heritag</b> requirements in relation to the				<u>ıld.gov.au</u> about the
Name of the heritage place:		F	Place ID:	
12) Does this development app  ☐ Yes – the <i>Referral checklist</i> ☐ No – proceed to Part 5				
No proceed to Fair 5				
13) Has any referral agency pro	ovided a referral re	esponse for this de	evelopment applic	ation?
Yes – referral response(s) re				
□ No				тет арризации
Referral requirement		Referra	l agency	Date referral response
'			<u> </u>	-
Identify and describe any chang referral response and this deve (if applicable)				
PART 5 – BUILDING W	ORK DETAII	_S		
PART 5 – BUILDING W	ORK DETAII	_S		
14) Owner's details				
			wise, provide the	following information.
14) Owner's details	he owner and prod		wise, provide the	following information.
☐ Tick if the applicant is also the	he owner and proo		wise, provide the	following information.
14) Owner's details  Tick if the applicant is also to Name(s) (individual or company full in	he owner and produced name)  anies)  Gra	ceed to 15). Other	·	following information.
14) Owner's details  Tick if the applicant is also the same (s) (individual or company full of Contact name (applicable for company)	he owner and production of the	ceed to 15). Other aham Larsen	·	following information.

Postcode					
Country					
Contact number					
Email address (non-mandatory)					
Mobile number (non-mandatory)					
Fax number (non-mandatory)					
15) Builder's details					
☐ Tick if a builder has not yet be following information.	been engage	d to undertake the	work and proceed to 16). (	Otherwise provide the	
Name(s) (individual or company full name)		Ocean to Outback			
Contact name (applicable for compa	anies)	Graham Larsen			
QBCC licence or owner – builde	er number	077 094			
Postal address (P.O. Box or street a	address)	569 McIntosh Cr	eek Road		
Suburb		McIntosh Creek			
State		QLD			
Postcode		4570			
Contact number		0427 739 939			
Email address (non-mandatory)					
Mobile number (non-mandatory)					
Fax number (non-mandatory)					
		•			
16) Provide details about the proposed building work					
What type of approval is being	sought?				
□ Development permit	sought?				
<ul><li>☑ Development permit</li><li>☑ Preliminary approval</li></ul>					
<ul><li>☑ Development permit</li><li>☐ Preliminary approval</li><li>b) What is the level of assessment</li></ul>					
<ul> <li>☑ Development permit</li> <li>☑ Preliminary approval</li> <li>b) What is the level of assessment</li> <li>☑ Code assessment</li> </ul>	ent?				
<ul> <li>☑ Development permit</li> <li>☐ Preliminary approval</li> <li>b) What is the level of assessment</li> <li>☐ Impact assessment (requires permit)</li> </ul>	ent?				
<ul> <li>☑ Development permit</li> <li>☐ Preliminary approval</li> <li>b) What is the level of assessment</li> <li>☐ Impact assessment (requires percent)</li> <li>c) Nature of the proposed building</li> </ul>	ent?		•	ntions or additions	
<ul> <li>☑ Development permit</li> <li>☑ Preliminary approval</li> <li>b) What is the level of assessment</li> <li>☑ Code assessment</li> <li>☑ Impact assessment (requires per composed buildition)</li> <li>☑ New building or structure</li> </ul>	ent? oublic notification ng work (tick	all applicable box	Repairs, altera	ations or additions	
<ul> <li>☑ Development permit</li> <li>☐ Preliminary approval</li> <li>b) What is the level of assessment</li> <li>☐ Impact assessment (requires percent)</li> <li>c) Nature of the proposed buildi</li> <li>☐ New building or structure</li> <li>☐ Change of building classification</li> </ul>	ent? oublic notification ng work (tick	all applicable box	☐ Repairs, altera	ol and/or pool fence	
<ul> <li>☑ Development permit</li> <li>☑ Preliminary approval</li> <li>b) What is the level of assessment</li> <li>☑ Code assessment (requires permit)</li> <li>☑ Impact assessment (requires permit)</li> <li>☑ Nature of the proposed buildi</li> <li>☑ New building or structure</li> <li>☑ Change of building classificat</li> <li>☑ Demolition</li> </ul>	ent?  public notification  ng work (tick  ation (involving	all applicable box	☐ Repairs, altera☐ Swimming poo	ol and/or pool fence	
<ul> <li>☑ Development permit</li> <li>☑ Preliminary approval</li> <li>b) What is the level of assessment</li> <li>☑ Code assessment</li> <li>☑ Impact assessment (requires percent)</li> <li>c) Nature of the proposed buildi</li> <li>☑ New building or structure</li> <li>☑ Change of building classification</li> </ul>	ent?  public notification  ng work (tick  ation (involving	all applicable box	☐ Repairs, altera☐ Swimming poo	ol and/or pool fence	
<ul> <li>☑ Development permit</li> <li>☐ Preliminary approval</li> <li>b) What is the level of assessment</li> <li>☐ Impact assessment (requires permit)</li> <li>C) Nature of the proposed buildi</li> <li>☐ New building or structure</li> <li>☐ Change of building classificat</li> <li>☐ Demolition</li> <li>d) Provide a description of the vertical properties of the proposed building classification</li> </ul>	ent?  public notification  ng work (tick  ation (involving)  vork below of	all applicable box	☐ Repairs, altera☐ Swimming poo	ol and/or pool fence	
<ul> <li>☑ Development permit</li> <li>☑ Preliminary approval</li> <li>b) What is the level of assessment</li> <li>☑ Code assessment</li> <li>☑ Impact assessment (requires permit)</li> <li>c) Nature of the proposed buildi</li> <li>☑ New building or structure</li> <li>☑ Change of building classificat</li> <li>☑ Demolition</li> </ul>	ent?  public notification ing work (tick ation (involving)  vork below of	all applicable box  building work)  r in an attached sc	☐ Repairs, altera☐ Swimming poo ☐ Relocation or hedule.	ol and/or pool fence removal	
<ul> <li>☑ Development permit</li> <li>☑ Preliminary approval</li> <li>b) What is the level of assessment</li> <li>☑ Code assessment (requires period)</li> <li>c) Nature of the proposed buildi</li> <li>☑ New building or structure</li> <li>☑ Change of building classificat</li> <li>☑ Demolition</li> <li>d) Provide a description of the vertical period</li> <li>e) Proposed construction mater</li> </ul>	ent?  public notification ng work (tick  ation (involving  work below or  ials	all applicable box  building work)  r in an attached sc  brick	☐ Repairs, altera☐ Swimming poo ☐ Relocation or hedule. ☐ Steel	ol and/or pool fence removal  Curtain glass	
<ul> <li>☑ Development permit</li> <li>☐ Preliminary approval</li> <li>b) What is the level of assessment</li> <li>☐ Impact assessment (requires permit)</li> <li>☐ Nature of the proposed buildi</li> <li>☐ New building or structure</li> <li>☐ Change of building classificat</li> <li>☐ Demolition</li> <li>d) Provide a description of the vertical properties of the proposed building classification</li> </ul>	ent?  public notification ing work (tick ation (involving)  vork below of	all applicable box  building work)  r in an attached sc  brick eneer	☐ Repairs, altera☐ Swimming pool ☐ Relocation or hedule.	ol and/or pool fence removal	
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<ul> <li>☑ Development permit</li> <li>☑ Preliminary approval</li> <li>b) What is the level of assessment</li> <li>☑ Code assessment (requires period)</li> <li>c) Nature of the proposed buildi</li> <li>☑ New building or structure</li> <li>☑ Change of building classificat</li> <li>☑ Demolition</li> <li>d) Provide a description of the vertical period</li> <li>e) Proposed construction mater</li> </ul>	ent?  public notification ng work (tick  ation (involving)  work below or  ials  Double Brick ve	all applicable box  building work)  r in an attached sc  brick eneer	Repairs, altera Swimming pool Relocation or hedule.  Steel Timber Fibre cement	ol and/or pool fence removal  Curtain glass Aluminium	
<ul> <li>☑ Development permit</li> <li>☑ Preliminary approval</li> <li>b) What is the level of assessment</li> <li>☑ Code assessment (requires permit)</li> <li>☑ Impact assessment (requires permit)</li> <li>☑ New building or structure</li> <li>☑ Change of building classification</li> <li>☑ Demolition</li> <li>d) Provide a description of the vertical walls</li> </ul> External walls	ent?  public notification ing work (tick ation (involving)  vork below of ials  Double Brick ve Stone/c	all applicable box  building work)  r in an attached sc  brick eneer oncrete	Repairs, altera Swimming pool Relocation or hedule.  Steel Timber Fibre cement	ol and/or pool fence removal  Curtain glass Aluminium Other	
□ Development permit     □ Preliminary approval     b) What is the level of assessment     □ Impact assessment (requires percent)     □ New building or structure     □ Change of building classification     □ Demolition     d) Provide a description of the vertice of the proposed building classification     □ Demolition     d) Provide a description of the vertice of the proposed construction materials.  External walls  Frame  Floor	ent?  public notification ng work (tick  ation (involving)  vork below of  ials  Double Brick ve Stone/c  Timber Other	all applicable box  building work)  r in an attached sc  brick eneer oncrete	Repairs, altera Swimming pool Relocation or hedule.  Steel Timber Fibre cement Steel	ol and/or pool fence removal  Curtain glass Aluminium Other Aluminium	
<ul> <li>☑ Development permit</li> <li>☑ Preliminary approval</li> <li>b) What is the level of assessment</li> <li>☑ Code assessment (requires permit)</li> <li>☑ Impact assessment (requires permit)</li> <li>☑ New building or structure</li> <li>☑ Change of building classification</li> <li>☑ Demolition</li> <li>d) Provide a description of the vertical walls</li> <li>External walls</li> </ul>	ent?  public notification ing work (tick ation (involving)  vork below of ials  Double Brick ve Stone/c  Timber Other Concret	all applicable box  building work)  r in an attached sc  brick eneer oncrete	Repairs, altera Swimming pool Relocation or hedule.  Steel Timber Fibre cement Steel Timber	ol and/or pool fence removal  Curtain glass Aluminium Other Aluminium Other	

g) New building use/classificati	on? (if applicable)	
h) Relevant plans  Note: Relevant plans are required to b  Relevant plans.	e submitted for all aspects of this development ap	plication. For further information, see <u>DA Forms Guide:</u>
Relevant plans of the propo	sed works are attached to the developm	nent application
( <del></del>		
	e of the proposed building work?	
\$		
18) Has Queensland Home Wa	arranty Scheme Insurance been paid?	
☐ Yes – provide details below ☐ No		
Amount paid	Date paid (dd/mm/yy)	Reference number
\$		
PART 6 – CHECKLIST  19) Development application cl	AND APPLICANT DECLAR	ATION
· · · · · · · · · · · · · · · · · · ·	Building work details have been comple	eted X Yes
This development application in	ncludes a material change of use, recon panied by a completed <i>Form 1 – Develo</i>	figuring a lot or Yes
•	nent are attached to this development ap e submitted for all aspects of this development ap evant plans.	·
The portable long service leave a development permit is issued	e levy for QLeave has been paid, or will (see 9)	be paid before  ☐ Yes ☐ Not applicable
20) Applicant declaration		
By making this developmen correct	t application, I declare that all information	n in this development application is true and
from the assessment mana information is required or pe Note: It is unlawful to intentionally prov	ger and any referral agency for the deve ermitted pursuant to sections 11 and 12 vide false or misleading information.	of the Electronic Transactions Act 2001
assessment manager, any refer be engaged by those entities) of All information relating to this dispublished on the assessment re	while processing, assessing and decidin levelopment application may be availabl nanager's and/or referral agency's webs e disclosed for a purpose unrelated to th	uding any professional advisers which may g the development application. e for inspection and purchase, and/or
Act 2016 and the Planning Planning Regulation 2017;	Regulation 2017, and the access rules r or	-
<ul><li>required by other legislation</li><li>otherwise required by law.</li></ul>	in (including the Right to Information Act	2009); or
	l in relevant databases. The information	collected will be retained as required by the

## PART 7 – FOR COMPLETION BY THE ASSESSMENT MANAGER – FOR OFFICE USE ONLY


Date received:	Reference r	numbers:	
For completion by the buildin	g certifier		
Classification(s) of approved	building work		
Name		QBCC Certification Licence number	QBCC Insurance receipt number
Notification of engagement o	f alternative assessm	ent manager	
Prescribed assessment mana	ager		
Name of chosen assessment	manager		
Date chosen assessment ma	nager engaged		
Contact number of chosen as	ssessment manager		
Relevant licence number(s) of chosen assessment manager		t	
Additional information require	ed by the local govern	ment	
Confirm proposed construction			
External walls	☐ Double brick ☐ Brick veneer ☐ Stone/concret	☐ Steel ☐ Timber e ☐ Fibre cement	☐ Curtain glass ☐ Aluminium ☐ Other
Frame	☐ Timber ☐ Other	☐ Steel	Aluminium
Floor	☐ Concrete	Timber	Other
Roof covering Slate/concrete Aluminium		e ☐ Tiles ☐ Steel	☐ Fibre cement ☐ Other
QLeave notification and payn			
Description of the work			
QLeave project number			
Amount paid (\$)		Date paid (dd/mm/yy)	
Date receipted form sighted by	oy assessment manaç	ger	
Name of officer who sighted	the form		
Additional building details red	uired for the Australia	an Bureau of Statistics	
Existing building use/classific	•		
New building use/classification			
Site area (m²)			


#### CONCRETE/FOUNDATION NOTES:

- All concrete shall be 25MPa UNO with 20mm nominal maximum aggregate size and 80mm slump to AS3600.
- No on site water to be added to the concrete unless approved by the engineer.
- All Concrete to be mechanically vibrated so that the concrete is fully compacted U.N.O.
- Concrete is to be cured for a minimum of 7 days after initial set. The curing method is to be approved by the engineer.
- 5. Cover to reinforcement to be 40mm for all steelwork.
- Concrete shall not be poured when the air temperature is greater than 38 degrees or less than 5 degrees.
- Concrete footings and floors to be inspected by the engineer prior to pouring. The engineer is to be given 24 hrs. notice of such an inspection being required.
- Slab Mesh is to be lapped so as the two outermost transverse wires of one sheet overlap the two outermost transverse wires of the other sheet.
- All Reinforcement shall be adequately supported before commencement of concrete pour to ensure cover and placement of steel is maintained.
- Controlled Fill shall be clean granular material (free of clay) compacted to 95% standard compaction in layers no greater than 150mm.
- 11. FOUNDATION MATERIAL: Organic Material, soft spots, top soil and any other deleterious material shall be removed from footing or slab excavations. Excavations shall then be proof rolled and soft spots replaced with controlled fill if under slabs or 15Mpa mass concrete if under footings. Site to have a nominal bearing capacity of 100kPa and classification not greater than 'S'.

Soil test by Unearthed Geotechnical Report No. 023-128

- 12. Footings shall be founded below the bottom of existing or proposed adjoining service trenches. Excavations shall not be taken below the bottom of adjoining footings.
- The site shall be graded so that water cannot pond against or near the house.
- Care should be taken to control the flora so as to not adversely affect the drainage of the site.
- Site Classification "H1"

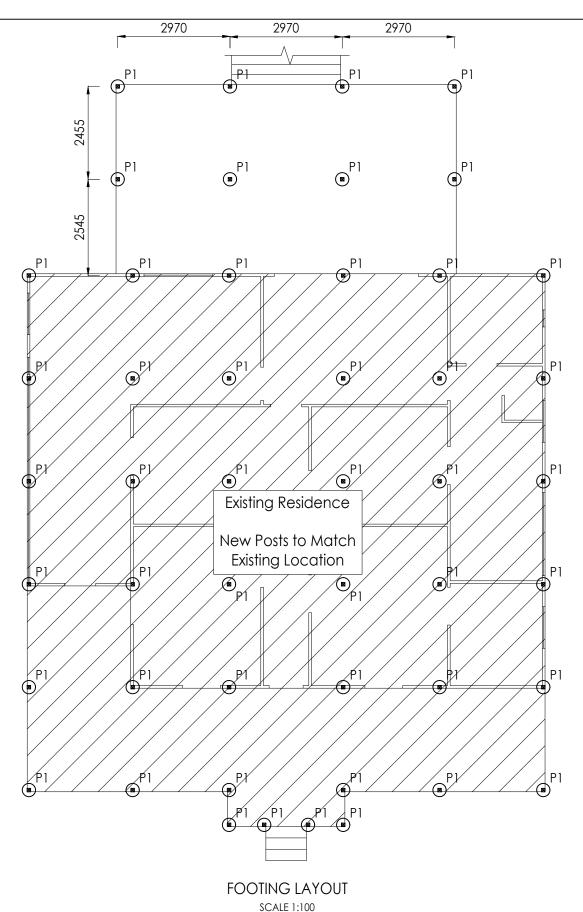

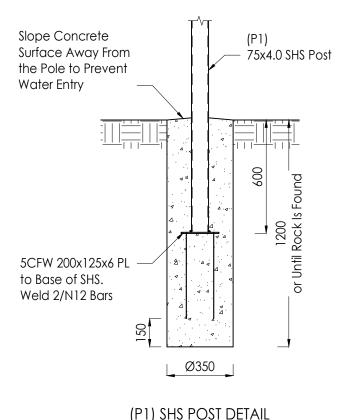

**SCALE 1:20** 

Mass Concrete Footing MIN Concrete Strength F'c=25MPa Maximum Aggegrate = 10mm Slump 50-75mm All Concrete to be Vibrated **During Placement** 


#### MATERIAL LIST Р1 75x4.0 SHS Post Post

### AAA Design & Development Pty Ltd

34/13 Norval Court, MAROOCHYDORE, QLD 4558

Tel/Fax: (07) 5479 6747 0422 039 247 Mob:

email: d.lesmes@aaadesign.com.au

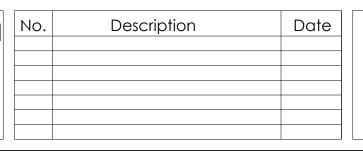

#### MARGE COCHRANE

24 Horton St, BIGGENDEN, QLD 4621

**RESIDENCE RELOCATION** 

## **APPROVED** Jose David Lesmes Tirado BEng, MIEAust, RPEQ 7198


#### CONCRETE FOOTING LAYOUT

Project number C250-01 4291 - 01 11/07/2023 Date

R.S. Drawn by esign & Development Consulting Checked by


D.L.T. Scale @ A3 As shown FLOOR DESIGNED FOR

DISTRIBUTED: 2.0 kPa CONCENTRATED: 1.8kN

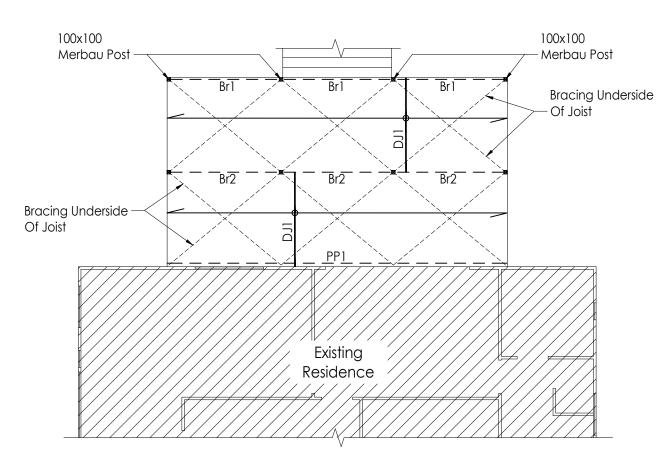

FLOOR LAYOUT SCALE 1:100


MATERIAL LIST		
Br1	Bearer	2/190x45 MGP10 Treated or 290x45 MGP10 Treated
Br2	Bearer	2/290x45 MGP10 Treated or 290x42 Merbau GL17S
DJI	Deck Joist	140x35 MGP10 @450 Crs Treated Continuous or 140x45 MGP10 @450 Crs Treated Single Span
PP1	Pole Plate	2/190x45 MGP10 Treated or 290x45 MGP10 Treated

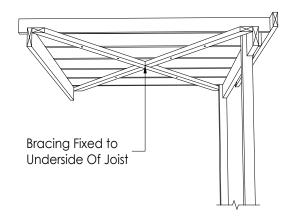

#### NOTE:

Timber Braces Shall Be Double Diagonal 100 x 38 mm Hardwood Or 90 x 45 mm Treated Pine, Halved At The Crossing.

Decks Double Diagonal Bracing Fixed to The Underside Of Joists With Each Brace Fixed to Each Joist With 75 mm No. 14 Type 17 Batten Screws Or Two 75 x 3.15 mm Nails

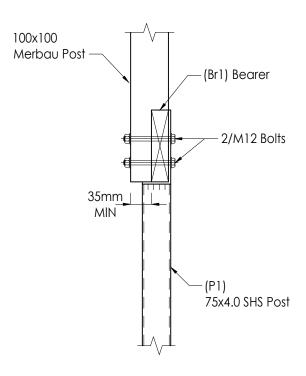

**BEARER TO POST** TYPICAL FIXING DETAIL


NTS

## AAA Design & Development Pty Ltd

34/13 Norval Court, MAROOCHYDORE, QLD 4558

Tel/Fax: (07) 5479 6747 Mob: 0422 039 247

email: d.lesmes@aaadesign.com.au

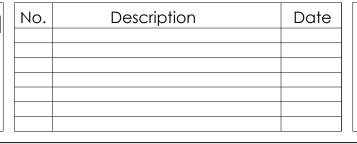

24 Horton St,

BIGGENDEN, QLD 4621

RESIDENCE RELOCATION


### **APPROVED** Jose David Lesmes Tirado BEng, MIEAust, RPEQ 7198 For & on behalf of AAA Design & Development Consulting Checked by

#### FLOOR LAYOUT

Project number C250-01 4291 - 02 11/07/2023 Date R.S. Drawn by


D.L.T. Scale @ A3

As shown

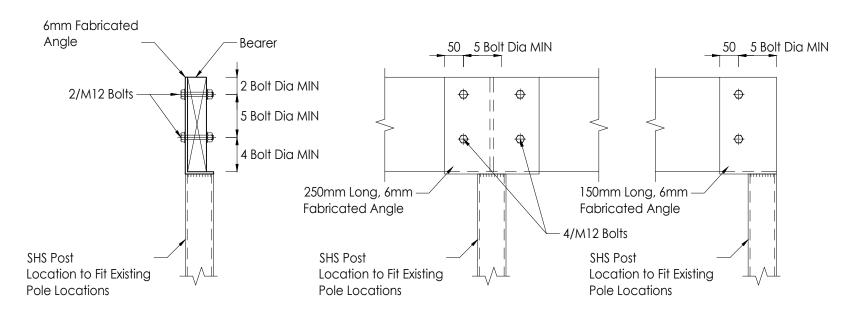

OPTION 1 TIMBER BEAM TO STEEL POST FIXING DETAILS

NTS

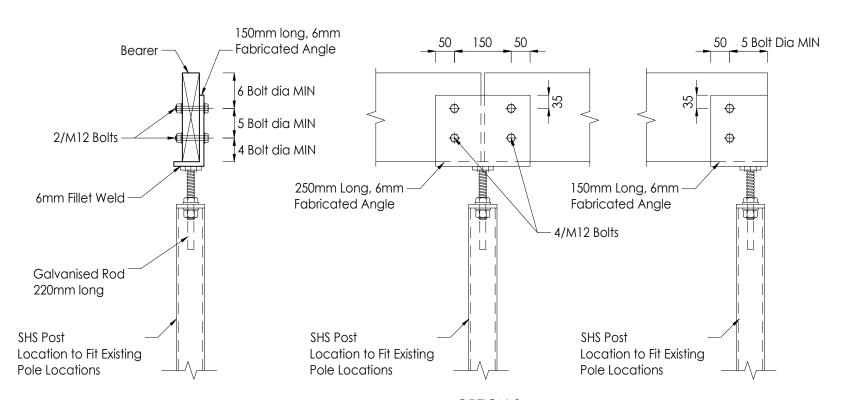


OPTION 2 TIMBER BEAM TO STEEL POST CONNECTION DETAIL

### AAA Design & Development Pty Ltd

34/13 Norval Court, MAROOCHYDORE, QLD 4558

Tel/Fax: (07) 5479 6747 Mob: 0422 039 247

email: d.lesmes@aaadesign.com.au

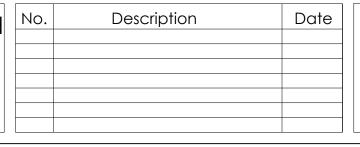

#### MARGE COCHRANE

24 Horton St,

BIGGENDEN, QLD 4621

**RESIDENCE RELOCATION** 

APPROVED
Jose David Lesmes Tirado
Julmy
BEng, MIEAust, RPEQ 7198
For & on behalf of AAA
asian & Development Consulting

#### **CONNECTION DETAILS**

Project number C250-01 Date Drawn by

M12 Bolts

Existing

Bearer

SHS Post

EXISTING BEAM TO STEEL POST

FIXING DETAILS

NTS

Pole Locations

Location to Fit Existing


Existing


Bearer

6mm Steel Plate, 4mm CFW to SHS Post

> 4291 - 03 11/07/2023 R.S.

Checked by D.L.T. Scale @ A3 As shown

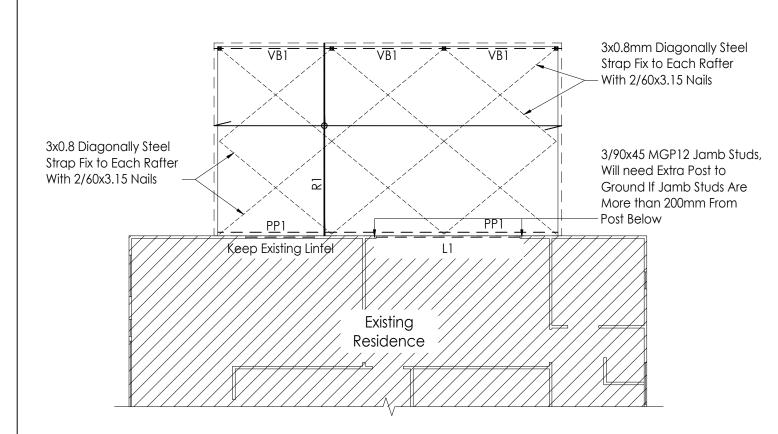

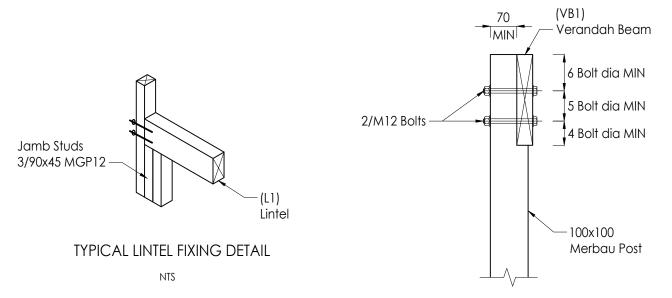

TIMBER BEAM TO TIMBER POST CONNECTION DETAIL

NTS

**ROOF LAYOUT** SCALE 1:100

MATERIAL LIST		
L1	Lintel	260x65 SmartLam GL17C
PP1	Pole Plate	240x45 MGP10 Treated
R1	Rafter	240x45 MGP10 @900 Crs Treated
VB1	Verandah Beam	240x42 Merbau GL17S or 2/190x45 MGP10 Treated

RAFTER TO HOUSE **CONNECTION DETAIL** NTS

RAFTER TIE-DOWN DETAIL


NTS

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MARGE COCHRANE	


24 Horton St, BIGGENDEN, QLD 4621


RESIDENCE RELOCATION

## **APPROVED** BEng, MIEAust, RPEQ 7198
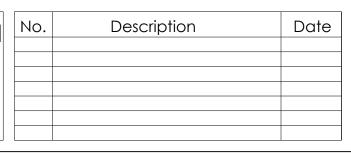
## **ROOF LAYOUT**


Amany	Project number C250-01			
0	Date	11/07/2023	4291	- 04
BEng, MIEAust, RPEQ 7198 For & on behalf of AAA	Drawn by	R.S.		
Design & Development Consulting	Checked by	D.L.T.	Scale @ A3	As shown

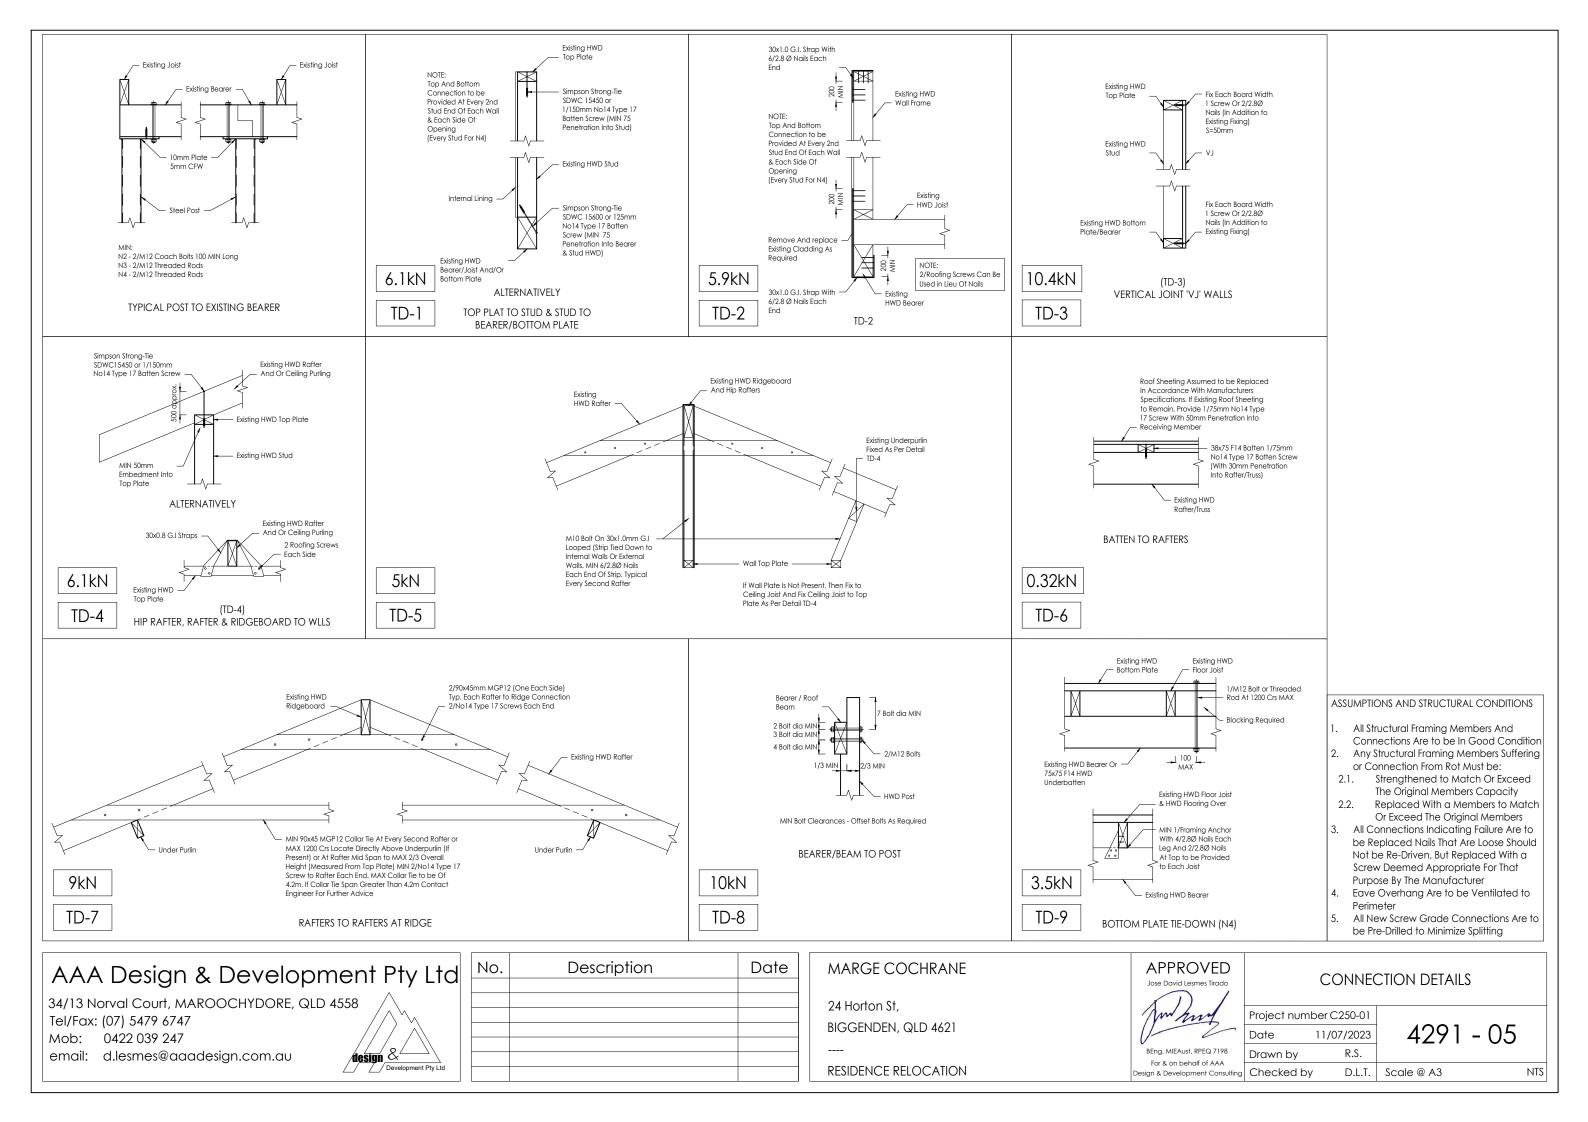

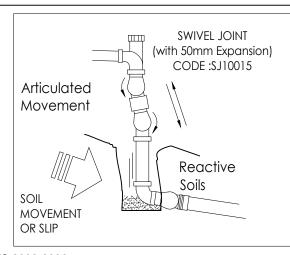


#### AS/NZS 2032-2006 Clause 3.7.1 Provision for Expansion and contraction.

Downpipes do not normally need special provision for expansion and contraction. However, when a downpipe is connected to a Stormwater pipe, or otherwise restrained at the discharge end, provisions shall be made to allow the pipe to expand and contract

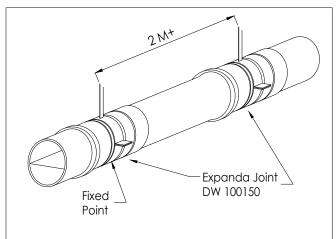


AS/NZS 2032-2006 Clause 6.4.2.2 (a) Expansion joints provided where distance between fixed points exceed 2 metres (cold pipelines)

**ELEVATION** 

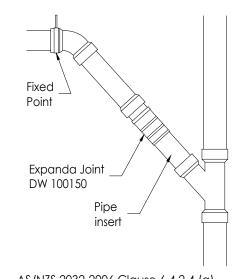


AS/NZS 2032-2006 Clause 6.4.2.4 (a) Expansion Joint at connection to stack

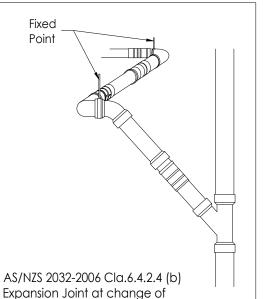

direction in graded lines.

AS/NZS 2032-2006 Clause 3.7.1 Provision for Expansion and Contraction

Clause 4.2.2 (g) **Solvent Cement Jointing** Allow the joints to cure for 24hrs. Do not fill the pipeline with water until at least 1 h after making the last joint. Do not pressurize for at least 24 h after making the last joint. - Downpipe

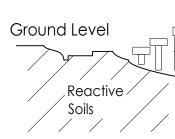

Clause 2.3: Hangers and Clips: Hangers and Clips shall be corrosion resistant for the intended environment.


Sliding Joints, pipe hangers and clips shall be constructed so that, when fully tightened, longitudinal movement of the pipe is possible without damage to the pipe or fitting.

Anchor clips for fixed points shall be constructed so that, when fully tightened, the fitting or pipe is securely and evenly clamped to prevent movement. Care shall be taken to ensure that pipes and fittings are not distorted by over tightening.

#### Clause 3.7.2 Vibration

Vibration of the pipe (e.g. at connections to water pumps) shall be avoided and where necessary, flexible couplings **shall** be installed to minimize transmission of vibration to the pipe work.

Soil test by Unearthed Geotechnical Job No. 023-128 Class "H1"

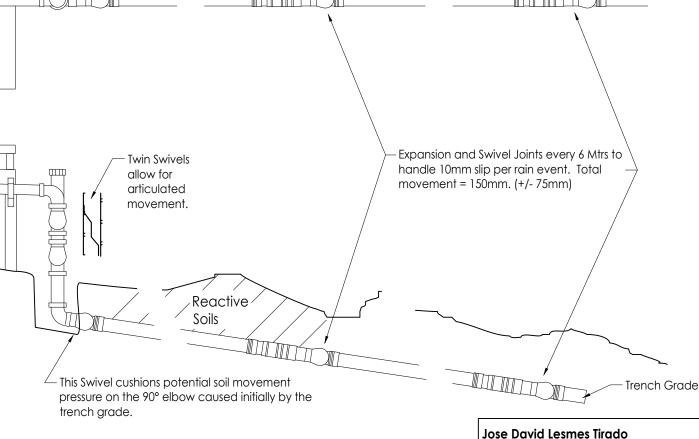


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# **APPROVED**

#### BEng, MIEAust, RPEQ 7198 For & on behalf of AAA Design & Development Consulting Checked by

## PLUMBING ARTICULATION

Structural Certificate

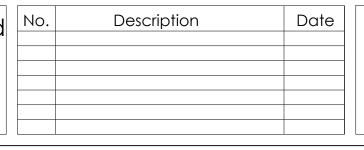Dated 11-07-2023

Project number C250-01 11/07/2023 Date R.S. Drawn by

4291 - 06

BEng Civil, MIEAust, RPEQ 07198 As Per

D.L.T. Scale @ A3